Σ					_	ALL DIMENSIONS ARE TO BE: GUARANTEED	CUSTOMER APPROVAL:			SHEET INDEX	
	WING NUMBER	206	44	140-	-В	GENERAL NOTES	-	N	10:	DESCRIPTION	REV
WINGS.			-			AUTOMATIC DOORS ARE CUSTOM IN NATURE AND REQUIRE LONG LEAD	DATE:	10	.01	SHEET INDEX	
_		Automatic Door	Threshold	Door Arm	Control Box	TIMES FOR MANUFACTURER.	APPROVED AS SU		.02	SYMBOLS AND NOTES	
IDAO		Configuration	Height & Type			 FRAMING NOTES: CONTRACTOR MUST GUARANTEE ALL DIMENSIONS. ROUGH OPENING MUST BE PLUMB, LEVEL & SQUARE. 	APPROVED AS NO	DTED 10	.03	INSTALLATION GUIDELINES	
HOLL	0)//		.25" RISER	RIXSON		• FINISHED FLOOR MUST NOT VARY MORE THAN 1/4" FROM HIGHEST TO LOWEST POINT.			.04	CBC PRESS PLATE GUIDELINES	
E MET		LHO	SURFACE	#327	IN CASE	• ELECTRICAL: 110VAC & LOW VOLTAGE - CONDUIT & WIRE PULL BY OTHERS.	CUSTON		01	PRODUCT SCHEDULE	
www.						 ALUMINUM BREAK METAL BY OTHERS - UNLESS SPECIFICALLY NOTED. CLEANING AND PROTECTION OF INSTALLED MATERIALS BY OTHERS. 		40	.01	ELEVATION	
5								50	01	SECTION VIEW	
						NOTES TO ARCHITECT, GC & CUSTOMER		60	02	FRONT AND PLAN VIEW (LHO)	
	9	SUBMITTAL	SECTION			ALL DRAWINGS AND DIMENSIONS ARE ASSUMED CORRECT UNLESS REDLINED AND RETURNED.		70	01	DOOR ARM (DOOR PREPERATION)	
	MATIC DOOR OPERATORS A		ORDINATION PROVID	DED. DOORS,		VERIFY ALL ROUGH/FINISHED OPENING DIMENSIONS.		70	02	STANDARD THRESHOLD PREPERATION	
FRAM	ES & HARDWARE ARE PRO	IDED BY OTHERS.				 VERIFY ALL SILL ANCHOR POINT LOCATIONS & DIMENSIONS. VERIFY STRUCTURAL INTEGRITY OF ALL SURROUNDING CONDITIONS FOR 	CONTRAC	CTOR	I		-
						JAMB & HEADER ATTACHMENT POINTS.					
						DESIGN CRITERIA					
							_				
							N				
	N	OTES TO A	RCHITECT								
							ADOUIT	FOT			
							ARCHIT	ECI			
							-				
							FURNISHED DO	CUMENTS			
								RCHITECTURALS			
							DATE:	-			
							YES NO X	STRUCTURAL			
							DATE:	-			
							YES NO X S	SPECIFICATION			
							SECTIONS DE	ESCRIPTION			
								1. ENT. & STFTS			
								SH HARDWARE			
								SS & GLAZING MATIC OPENERS			
							ADDENDUMS:	#			
NO:	DATE: REVISIO	N DESCRIPTION:						JOB NAME:			
19/2				AL:			_				
	 			<u>Rov</u>		Automated DO OR Solu	itions [.]	JOB ADDRESS:		PROJECT NO:	
				APP		by La 2834 Hamner Ave #308 Norco, CA 92860 www.Automat	t Force				
PRINTED				EER		Phone 866.945.7594 Sales@AutomatedDoorSol		JOB CITY:		SHEET SCALE:	
ATEP						PROJECT DESCRIPTION:		SHEET DESCRIPTION:		SHEET NO:	
			1712141					SHEET IND)FX	101	
	THIS DRAWING SC		ΤΙ Χ ΤΤ								

SWING DOOR CODE / ANSI REQUIRED DECALS	ABBREVIATIONS	SYMBOLS	DOOR TYPE LEGEND	REVISION NOTES	•
DECAL REFERENCE SHOWN ON ELEVATION:	AFF= ABOVE FINISHED FLOORBL= BOTTOM LOAD HEADERBO= BREAKOUT OPENING (MAX)BO?= BOTTOM OF ? \mathfrak{E} = CENTERLINECO= CUT OUTDLO= DAYLITE OPENINGDC= DOOR CLEARANCEDO= DOOR OPENINGDS= DOOR SIZEE= EXISTINGEA= EACHEQ= EQUALESO= ELECTRICAL STUB OUTFFL= FINISHED OPENINGFS= FRAME SIZEHG= HARDWARE GROUPHL= HEADER LENGTHIB= IN BETWEENMFR= MANUFACTURERMIN= MINIMUMMRK= NEWNC= NORMALLY CLOSEDNIC= NORMALLY OPENOC= ON CENTEROSA= OVERALL SERVICE ACCESSPP= PIVOT POINTPS= PANEL SIZEQTY= QUANTITYREF= REFERENCERO= ROUGH OPENINGSA= SERVICE ACCESSSDS= SEE DOOR SCHEDULESL= SIDE LOAD HEADERSO= SLIDE OPENINGTHOLD= THRESHOLDTLP= THOLD SMALL PIECETP= TERRAZZO PANUJ= UNDER JAMBVIF= VERIFY IN FIELD	#TITLEDETAIL VIEW: $#$ REFDETAIL REFERENCE: $DETAIL$ SHEETEXTERIOR 	SWING DOORS Also DENOTES HANDING: SPI=SIMULTANEOUS PAIR OUTSWING SPI=SIMULTANEOUS PAIR INSWING U/RHO = UNEVEN PAIR OUTSWING (RH-OUT) U/LHO = UNEVEN PAIR OUTSWING (LH-OUT) U/RHO = UNEVEN PAIR INSWING (RH-OUT) U/RHI = UNEVEN PAIR INSWING (RH-OUT) U/LHI = UNEVEN PAIR INSWING (LH-OUT) U/RHI = UNEVEN PAIR INSWING (LH-OUT) DE1=DUAL EGRESS 1 HEADER (INSWING/OUTSWING) DE2=DUAL EGRESS 2 HEADERS (OUTSWING) RHO=RIGHT HAND OUTSWING RHI=RIGHT HAND INSWING LHO=LEFT HAND INSWING LHI=LEFT HAND INSWING		
NO: DATE: REVISION DESCRIPTION:				JOB NAME:	
4/19/		Automated DO OR S	olutions	JOB ADDRESS:	PROJECT NO:
PRINTED: NEER APP		2834 Hamner Ave #308 Norco, CA 92860 www.Au Phone 866.945.7594 Sales@AutomatedD		JOB CITY:	SHEET SCALE:
THIS DRAWING SCALED TO PRINT 17" x 11"	PROJECT DESC	CRIPTION:		SYMBOLS AND NOTES	SHEET NO: 102



IN-GROUND INSTALLATION GUIDELINES:

1. PENETRATIONS: THE CEMENT CASE MUST ONLY BE PENETRATED TO INSTALL ELECTRIC POWER SERVICE AND LOW VOLTAGE SIGNAL WIRES. USE OF LIQUID TIGHT FITTINGS IS A CODE REQUIREMENT BY THE NATIONAL ELECTRIC CODE (NEC). ATTACHMENTS TO THE CEMENT CASE COVER ARE NEVER PERMITTED.

PLEASE NOTE: IN CERTAIN EXTERIOR CONDITIONS (DOWNGRADE ELEVATION, OPENINGS WITH DIRECT CONTACT TO PRECIPITATION, EXTREME HUMIDITY OR OTHER SIMILAR CONDITIONS) A DRAIN SYSTEM OR PROVISION FROM THE UNIT IS RECOMMENDED. IN ADDITION, THE CONTROL UNIT SHOULD BE MOUNTED IN AN ELEVATED POSITION OR REMOTELY LOCATED SEPARATE FROM THE UNIT. CONDENSATION RESULTING FROM TEMPERATURE AND OR CLIMATIC CONDITIONS IS A NATURALLY OCCURRING PROCESS AND NOT A WARRANTY PROVISION.

2. SEALS: ALL SEALS PROVIDED WITH THE IN-GROUND OPENER SYSTEM MUST BE INSTALLED INCLUDING:

A. SPINDLE SEAL AT COVER

C. PERIMETER GASKET BETWEEN CEMENT CASE AND COVER

SPECIAL NOTE ON SEALS: ANY SEAL FOUND TO BE DAMAGED OR WORN MUST BE REPLACED IMMEDIATELY TO MAINTAIN THE WARRANTY.

3. THRESHOLD: ALL THRESHOLDS MUST BE MANUFACTURED BY AAES OR MANUFACTURED TO AAES SPECIFICATIONS SHOWN ON INCLUDED SHOP DRAWINGS. THRESHOLDS MUST BE MANUFACTURED TO ACCEPT ALL SEALS, MUST BE REMOVABLE FOR FUTURE SERVICE, WITHOUT REMOVING DOOR AS SHOWN ON INCLUDED SHOP DRAWINGS AND MUST BE ATTACHED TO THE SURROUNDING FLOOR WITHOUT PENETRATING THE CEMENT CASE OR CEMENT CASE COVER. ALL CEMENT CASE COVERS MUST HAVE A PERIMETER SEAL OF SILICONE OR SIMILAR WATER PROOFING SEALANT APPLIED TO KEEP WATER FROM ENCROACHING INTO THE CEMENT CASE.

4. PRESSURE WASHING IS NEVER PERMITTED AT OR NEAR THE IN-GROUND OPENER INSTALLATION.

SUP			
NO: DATE: REVISION DESCRIPTION:		JOB NAME:	
	Automated DOOR Solutions	JOB ADDRESS:	PROJECT NO:
	2834 Hamner Ave #308 Norco, CA 92860 www.AutomatedDoorSolutions.com	JOB CITY:	SHEET SCALE:
	Phone 866.945.7594 Sales@AutomatedDoorSolutions.com		NONE
	PROJECT DESCRIPTION:	SHEET DESCRIPTION:	SHEET NO:
THIS DRAWING SCALED TO PRINT 17" x 11"		INSTALLATION GUIDELINES	103



PRESS PLATE LOCATION(S) MUST CONFORM WITH CBC11B-305.3 AS INDICATED IN 11B-404.2.9 EXCEPTION 2C.

COM

C,

SHOPDRAWING

WWW.

11B-305.4 KNEE AND TOE CLEARANCE. UNLESS OTHERWISE SPECIFIED, CLEAR FLOOR OR GROUND SPACE SHALL BE PERMITTED TO INCLUDE KNEE AND TOE CLEARANCE COMPLYING WITH SECTION 11B-306.

11B-305.5 POSITION. UNLESS OTHERWISE SPECIFIED, CLEAR FLOOR OR GROUND SPACE SHALL BE POSITIONED FOR EITHER FORWARD OR PARALLEL APPROACH TO AN ELEMENT.

11B-305.6 APPROACH. ONE FULL UNOBSTRUCTED SIDE OF THE CLEAR FLOOR OR GROUND SPACE SHALL ADJOIN AN ACCESSIBLE ROUTE OR ADJOIN ANOTHER CLEAR FLOOR OR GROUND SPACE.

11B-305.7 MANEUVERING CLEARANCE. WHERE A CLEAR FLOOR OR GROUND SPACE IS LOCATED IN AN ALCOVE OR OTHERWISE CONFINED ON ALL OR PART OF THREE SIDES, ADDITIONAL MANEUVERING CLEARANCE SHALL BE PROVIDED IN ACCORDANCE WITH SECTIONS 11B-305.7.1 AND 11B-305.7.1.

11B-305.7.1 FORWARD APPROACH. ALCOVES SHALL BE 36 INCHES WIDE MINIMUM WHERE THE DEPTH EXCEEDS 24 INCHES.

11B-305.7.2 PARALLEL APPROACH. ALCOVES SHALL BE 60 INCHES WIDE MINIMUM WHERE THE DEPTH EXCEEDS 15 INCHES.


EXCEPTION-2C. POWERED DOORS SHALL BE CONTROLLED ON BOTH THE INTERIOR AND EXTERIOR SIDES OF THE DOORS BY SENSING DEVICES, PUSH PLATES, VERTICAL ACTUATION BARS OR OTHER SIMILAR OPERATING DEVICES COMPLYING WITH SECTIONS 11B-304, 11B-305 AND 11B-308.

AT EACH LOCATION WHERE PUSH PLATES ARE PROVIDED THERE SHALL BE TWO PUSH PLATES; THE CENTERLINE OF ONE PUSH PLATE SHALL BE 7 INCHES (178 MM) MINIMUM AND 8 INCHES (203 MM) MAXIMUM ABOVE THE FLOOR OR GROUND SURFACE AND THE CENTERLINE OF THE SECOND PUSH PLATE SHALL BE 30 INCHES (762 MM) MINIMUM AND 44 INCHES (1118 MM) MAXIMUM ABOVE THE FLOOR OR GROUND SURFACE. EACH PUSH PLATE SHALL BE A MINIMUM OF 4 INCHES (102 MM) DIAMETER OR A MINIMUM OF 4 INCHES BY 4 INCHES (102 MM BY 102 MM) SQUARE AND SHALL DISPLAY THE INTERNATIONAL SYMBOL OF ACCESSIBILITY COMPLYING WITH SECTION 11B-703.7.

AT EACH LOCATION WHERE VERTICAL ACTUATION BARS ARE PROVIDED THE OPERABLE PORTION SHALL BE LOCATED SO THE BOTTOM IS 5 INCHES (127 MM) MAXIMUM ABOVE THE FLOOR OR GROUND SURFACE AND THE TOP IS 35 INCHES (889 MM) MINIMUM ABOVE THE FLOOR OR GROUND SURFACE. THE OPERABLE PORTION OF EACH VERTICAL ACTUATION BAR SHALL BE A MINIMUM OF 2 INCHES (51 MM) WIDE AND SHALL DISPLAY THE INTERNATIONAL SYMBOL OF ACCESSIBILITY COMPLYING WITH SECTION 11B-703.7.

WHERE PUSH PLATES, VERTICAL ACTUATION BARS OR OTHER SIMILAR OPERATING DEVICES ARE PROVIDED, THEY SHALL BE PLACED IN A CONSPICUOUS LOCATION. A LEVEL AND CLEAR FLOOR OR GROUND SPACE FOR FORWARD OR PARALLEL APPROACH COMPLYING WITH SECTION 11B-305 SHALL BE PROVIDED, CENTERED ON THE OPERATING DEVICE. DOORS SHALL NOT SWING INTO THE REQUIRED CLEAR FLOOR OR GROUND SPACE.

21	NO:	DATE:	REVISION DESCRIPTION:						
4/19/21				· IV/					
				PO O					
PRINTED:				APPR					
NIN				FFR					
				JUP					
DATE				FNG					
		THIS DRAWI	NG SCALED TO PRINT 17" x 11"						

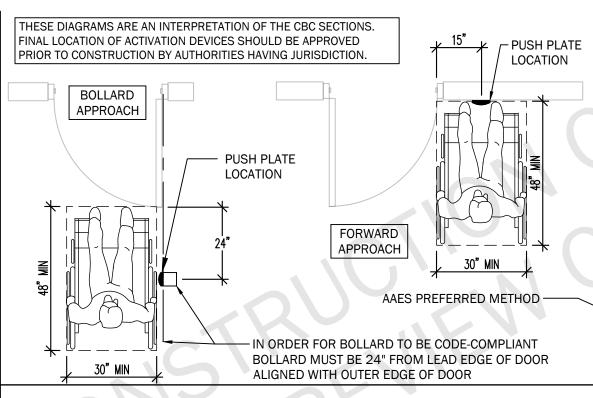



JOB ADDRESS: JOB CITY:

SHEET DESCRI


JOB NAME:

2834 Hamner Ave #308 Norco, CA 92860 | www.AutomatedDoorSolutions.com Phone 866.945.7594 | Sales@AutomatedDoorSolutions.com

PROJECT DESCRIPTION:

PUSH PLATE 24"	PARALLEL
	PROJECT NO:
PTION:	SHEET SCALE:
ALLATION GUIDELINES	SHEET NO: 104


Z				PRODUCT SCHEDULE			(#) MATERIAL LIST
S.C(110	SINGLE PHASE110VAC, DEDICATED GFCI CIRCUIT, REQUIRED. CONDUIT & WIRE	QTY DESCRIPTION		MRK	QTY	DESCRIPTION
	110	PULL BY DIVISION 16.	01 EA SW200i IN-GR	OUND SWING DOOR OPERATOR(S)	GRT	-	MFR RECOMMENDED NON-SHRINKING GROUT
RAV	INT	EXCLUSION: 8/22 LOW VOLTAGE CABLING REQUIRED FOR AUTOMATIC OPENER INTERFACE. CONDUIT & WIRE PULL BY OTHERS					PUSH PLATE: WIKK INGRESS'R VERTICAL ACTIVATION DEVICE WITH "PUSH
品		EXCLUSION: (2) CONDUIT REQUIRED FOR AUTOMATIC OPENER INTERFACE	ISOLATED PIVOT HEA	AVY DUTY OPENER			TO OPEN" & INTERNATIONAL ADA SYMBOL ENGRAVED INTO FACEPLATE.
SCH	CON	BETWEEN PAIRED OPERATOR HOUSINGS. ONE CONDUIT FOR 110VAC AND ONE		AES 109408 HD ENDLOAD DOOR ARM	P2	UU EA	FACE PLATE FINISH: BRUSHED STAINLESS STEEL 630 ENGRAVING FINISH: BLUE POWDER COAT
/.PR(CONDUIT FOR INTERFACE. CONDUIT & WIRE PULL BY OTHERS	• 5/16 HP MOTOR				NOTE: SHOWN FOR ILLUSTRATION PURPOSE ONLY
$\tilde{\mathbf{A}}$	CR	EXCLUSION: CARD READER/REMOTE OPEN - (NO) DRY CONTACT - MOMENTARILY CLOSES UPON VALID CARD READ. CONDUIT & WIRE PULL BY OTHERS.	MICROPROCESSED (CONTROL			BOLLARD: WIKK BOLLARD SQ11 42" X 6" STAINLESS STEEL WITH CARD READER ABOVE.
>-		POWER SUPPLY: EXCLUSION, BY OTHERS. MOUNTED BY ELECTRICAL		TH ANSI 156.19 STANDARDS	— B2	00 EA	FINISH: BRUSHED STAINLESS STEEL 630
	PS	CONTRACTOR. LOCATION MUST ALLOW FOR FUTURE SERVICE, AND MUST NOT BE OVER 50' FROM OPENING.		SIZE AND CONFIGURATION			NOTE: SHOWN FOR ILLUSTRATION PURPOSE ONLY
	EX	EXCLUSION: 4/18 LOW VOLTAGE CABLING REQUIRED FOR ELECTRIC LATCH		(#) NOTES			
-		RETRACTION. CONDUIT & WIRE PULL BY OTHERS.		SHED FLOOR, DOORS, FRAMES AND HARDWARE NOT SPECIFICALL		ER CONC	CEALED ELECTRIC STRIKE INTERFACE
	LV	EXCLUSION: LOW VOLTAGE - SEE ELEVATION FOR ALL LOW VOLTAGE REQUIREMENTS. CONDUIT & WIRE PULL BY OTHERS. SHOWN FOR ELECTRICAL	EXISTING PINE LISTED IS BY C			-	
		PREPARATION REQUIREMENTS.	CO CONCRETE CU	TOUT BY OTHERS			
		EXCLUSION: 6/22 SHIELDED LOW VOLTAGE CABLING REQUIRED FOR EACH PRESS PLATE. 4S ELECTRICAL BOX REQUIRED WITH 1 OR 2 GANG MUD RING. CONDUIT,	K 3/4" ELECTRIC	CAL KNOCKOUT		1	
	PSH	BOX & WIRE PULL BY OTHERS. NOTE: MUST BE LOCATED 24" BEYOND SWING	S SHAFT SEAL				
	FJII	PATH OF DOOR TO BE CODE COMPLIANT. *THIS CABLE MUST BE CONTINUOUS FROM PRESS PLATE TO AUTOMATIC	C C CHANNEL W	ELDED TO COVER			
		OPENER.		RAINAGE *REQUIRED FOR WARRANTY. UNIT IS WATER RESISTANT, CONDENSATION THAT BUILDS UP OVER TIME INSIDE HOUSING.			
		GENERAL ELECTRICAL NOTES		S A 3" CORE DRILL. THIS IS A BRASS SINK DRAIN, 1" PIPE SIZE, 2"			
		K BOXES: ALL PUSH PLATE LOCATIONS PER ARCHITECTURAL DRAWINGS. HOWEVER,	TOP DIAMETER	R AND 3 1/4" LONG. FITS 1 3/8" SINK OPENING, INCLUDES RUBBER WASHER. THE ACTUAL PHYSICAL OUTER THREAD			
		ACK BOXES MUST BE LOCATED 24" BEYOND SWING PATH OF DOOR TO BE CODE PLIANT.	DIAMETER IS				
	CONT			ACCESS REQUIRED THRU-OUT THE CASE. HOWEVER, SERVICE IRED WITHOUT REMOVING DOOR. SHOWN AS SEPARATE SA.			
				OF THE OPERATOR HOUSING WITH PHYSICAL ATTACHMENTS FOR			
				IR ANY OTHER HARDWARE CAN CAUSE DAMAGE AND LEAKAGE INT R AND SHALL VOID ALL WARRANTIES EXPRESSED OR IMPLIED	<u>o</u>		
				IGHT OF DOOR IS 500 LBS			
⊣⊢	NO:	DATE: REVISION DESCRIPTION:				JOB NA	ME:
	+	HI:					
4				Automated DO OR Solutions		JOB AD	DRESS: PROJECT NO:
		APP		2834 Hamner Ave #308 Norco, CA 92860 www.AutomatedDoorSolutions.com		10	
Ĭ	\square			2834 Hammer Ave #308 Norco, CA 92860 www.AutomatedDoorSolutions.com Phone 866.945.7594 Sales@AutomatedDoorSolutions.com		JOB CIT	TY: SHEET SCALE: NONE
╧┝			PROJE	ECT DESCRIPTION:		SHEET	DESCRIPTION: SHEET NO:
┑┝							ODUCT SCHEDULE 201
L		THIS DRAWING SCALED TO PRINT 17" x 11"					

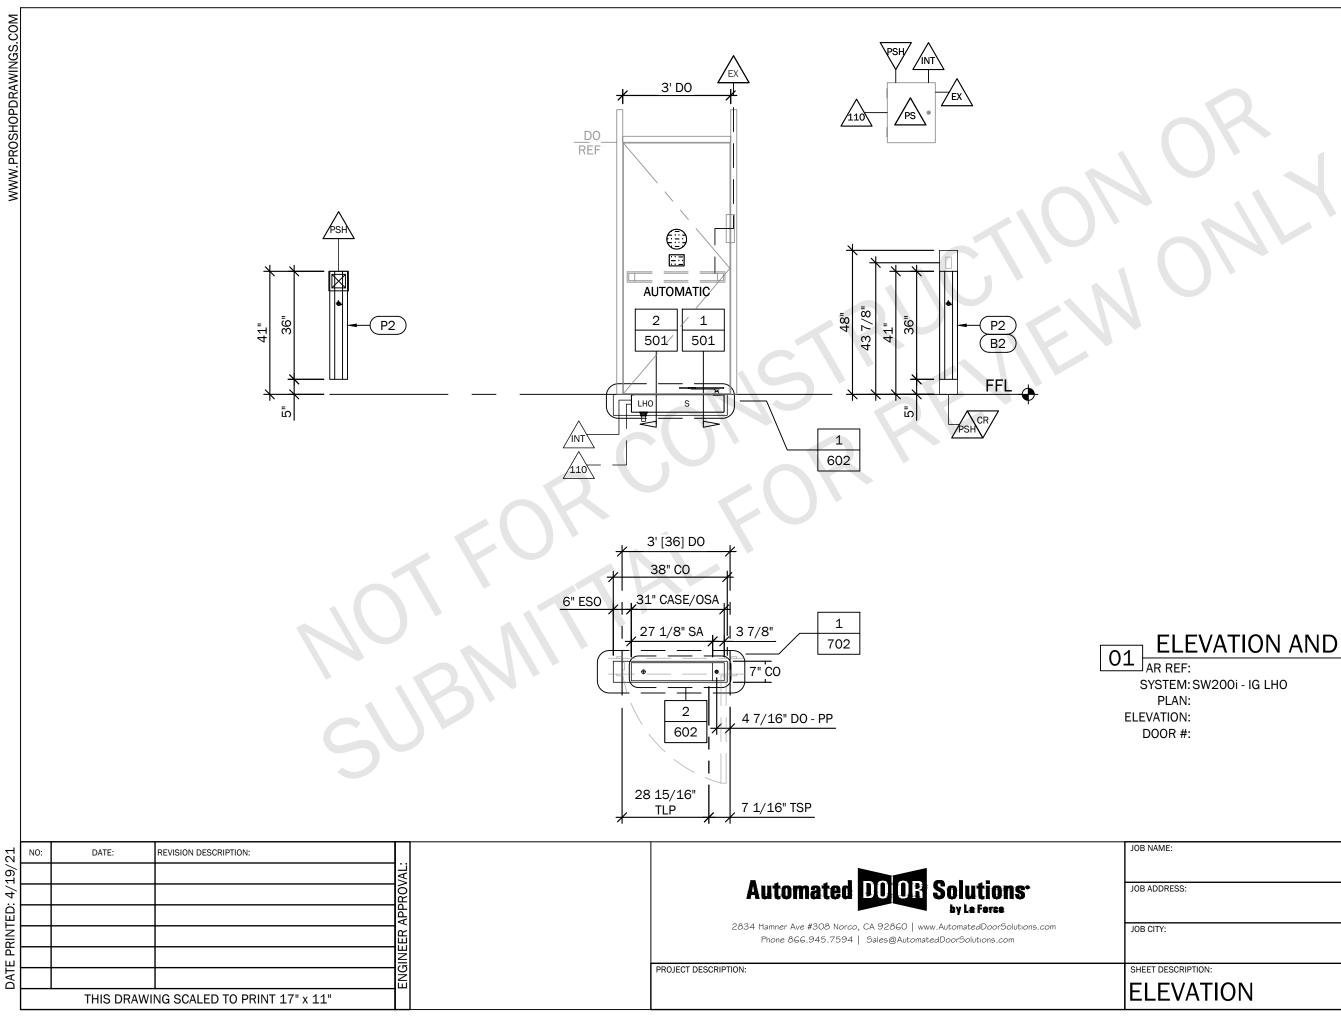


ELEVATION AND PLAN

QTY: FINISH: H. GROUP: LOCATION:

	PROJECT NO:
	SHEET SCALE:
	3/8" = 1'-0"
PTION:	SHEET NO:
ATION	401

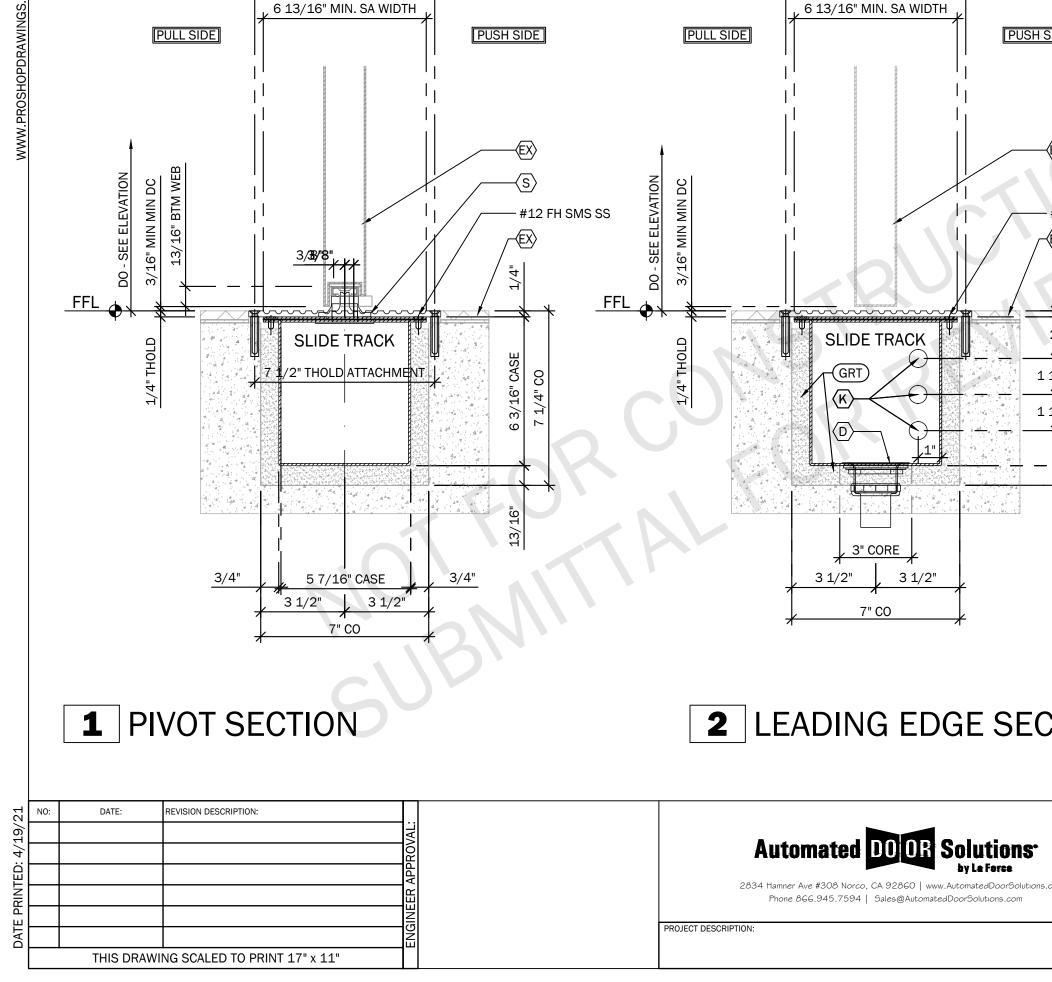

7 1/2" THOLD ATTACHMENT

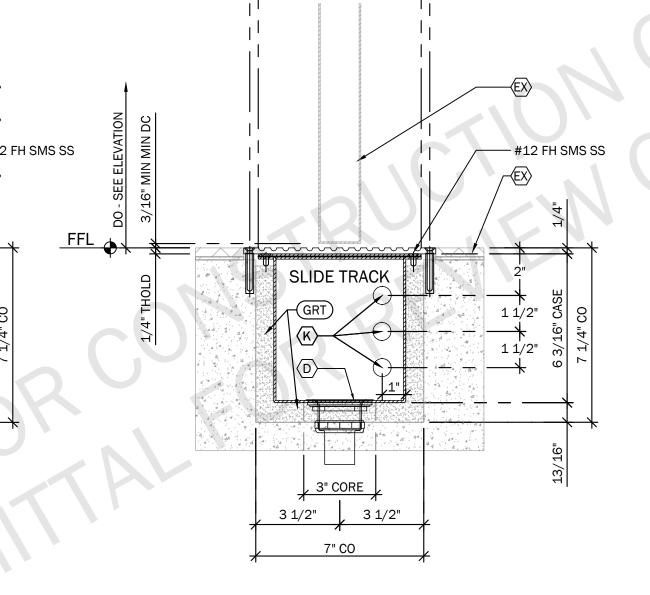

7 1/2" THOLD ATTACHMENT

PUSH SIDE

2 LEADING EDGE SEC

by La Force


TION	HOUSING WITH PHYSICAL ATTACHMENTS FOR THRESHOLD OR ANY OTHER HARDWARE CAN CAUSE DAMAGE AND LEAKAGE INTO THE OPERATOR AND SHALL VOID ALL WARRANTIES EXPRESSED OR IMPLIED	
	JOB NAME:	
	JOB ADDRESS:	PROJECT NO:
com	JOB CITY:	SHEET SCALE: 3'' = 1'-0''
	SHEET DESCRIPTION:	SHEET NO:
	SECTION VIEWS	501

WWW.PROSHOPDRAWINGS.COM

THRESHOLD SYSTEMS PROVIDED BY OTHERS SHALL BE PREPARED AND INSTALLED TO ALLOW FOR COMPLETE ACCESS TO THE OPERATOR, CONTROL AND PIVOT SYSTEM WITHOUT DOOR REMOVAL.

PENETRATION OF THE OPERATOR




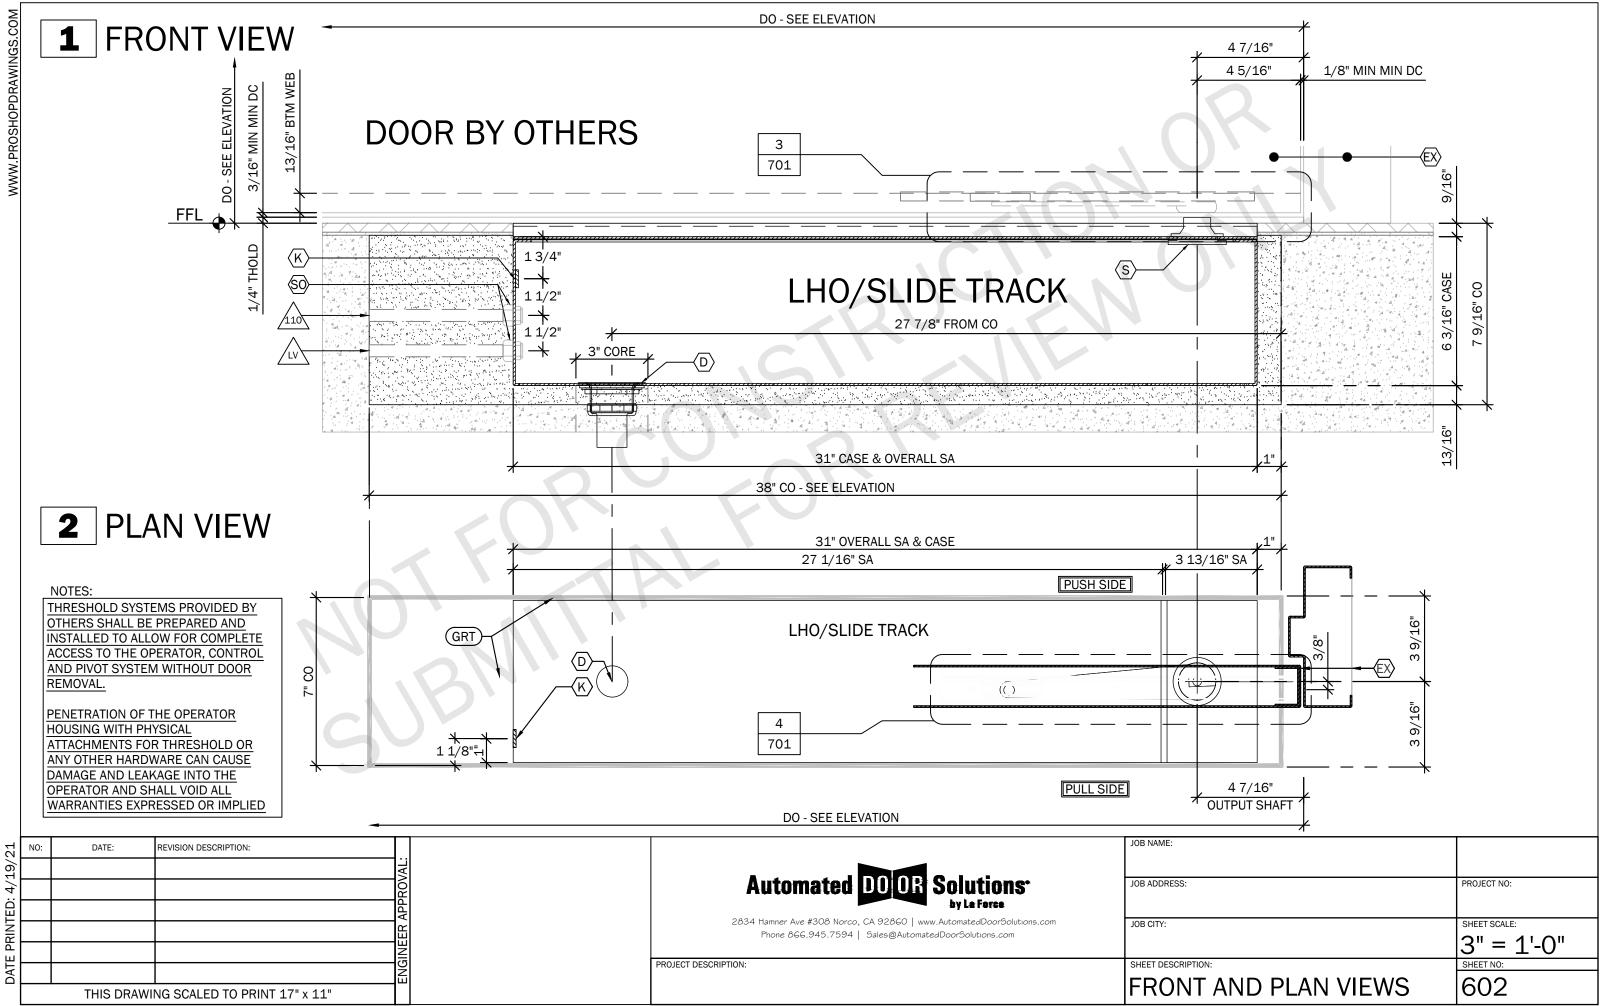

_	
\geq	
00	
Ō	
<i>.</i>	
22	
INGS.(
\leq	
\geq	
7	
~	
5	
E I	
¥	
승	
8	
2	
PROSHOPDF	
<u>н</u> .	
~	
5	
2	
>	

DATE PRINTED: 4/19/21

				TYPICAL	RIXSUN #32
				SLIDE TRACK CUT OUT	
				3/4" 3/4" 3/4" 	,
NO: DATE:	REVISION DESCRIPTION:				JOB NAME:
		ZOVAL:	Automated DO OR S	colutions [.]	JOB ADDRESS:
		ENGINEER APPROVA	2834 Hamner Ave #308 Norco, CA 92860 www.A	NutomatedDoorSolutions.com	JOB CITY:
		GINEE	Phone 866.945.7594 Sales@Automated[PROJECT DESCRIPTION:	JOOTOOIULION5.COM	SHEET DESCRI
THIS DF	AWING SCALED TO PRINT 1				DOOF

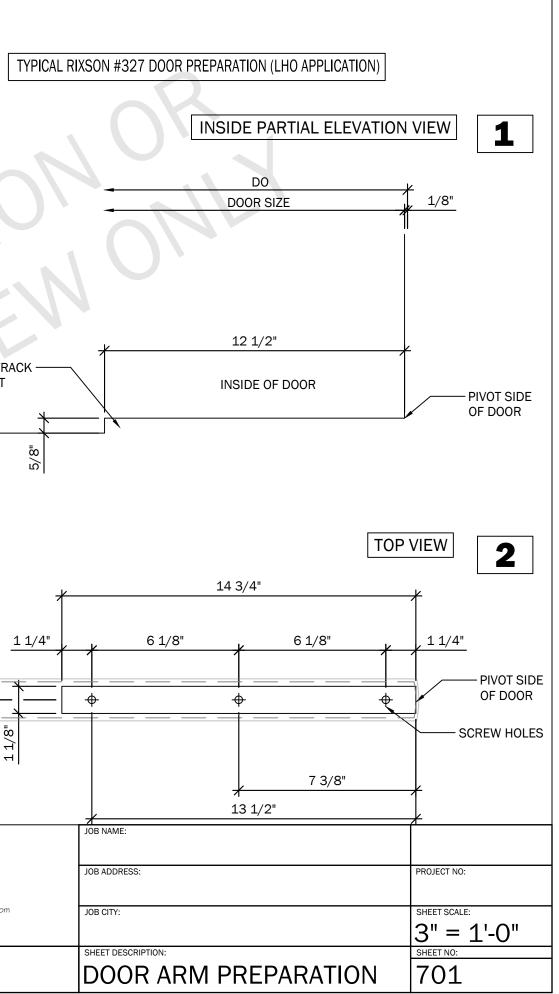

WWW.PROSH		THRESHOLD SYSTEMS PROVIDED BY OTHERS SHALL BE PREPARED AND INSTALLED TO ALLOW FOR COMPLETE ACCESS TO THE OPERATOR, CONTROL AND PIVOT SYSTEM WITHOUT DOOR REMOVAL.
		PENETRATION OF THE OPERATOR HOUSING WITH PHYSICAL ATTACHMENTS FOR THRESHOLD OR ANY OTHER HARDWARE CAN CAUSE DAMAGE AND LEAKAGE INTO THE OPERATOR AND SHALL VOID ALL WARRANTIES EXPRESSED OR IMPLIED
	Be Be Be Contract of the second secon	
-	2 15/16" 6 1/2" 6 1/2" 6 1/2"	2 7/8"
PRINTED: 4/19/21	NO: DATE: REVISION DESCRIPTION: Image: Constraint of the second	Automated DOOR Solutions by La Force 2834 Hamner Ave #308 Norco, CA 92860 www.AutomatedDoorSolutions.com Phone 866.945.7594 Sales@AutomatedDoorSolutions.com
DATE F	THIS DRAWING SCALED TO PRINT 17" x 11"	PROJECT DESCRIPTION:

1

SHAFT C	OLD OUTPUT OVER 1 THUS
7 1/16" 5 15/16" 1 1/8"	
1 1/2" 5 9/16" 1 1/0	
* * * 1 1	
	1 9/16"
SHAFT & SEAL	1#10 7
[[]] = [] COUNTERSINK	1 0 4
	· — — 🕇
	3 15/16"
ā,	3 15
<u>1 1/2"</u> <u>3 1/16"</u> <u>2 1/2"</u>	· — — — + _ +
JOB NAME:	
JOB ADDRESS:	PROJECT NO:
JOB CITY:	SHEET SCALE:
	3" = 1'-0"
THRESHOLD PREPARATION	SHEET NO: 702